


**1 FIRST FLOOR PLAN**  
SCALE: 1/4" = 1'-0"

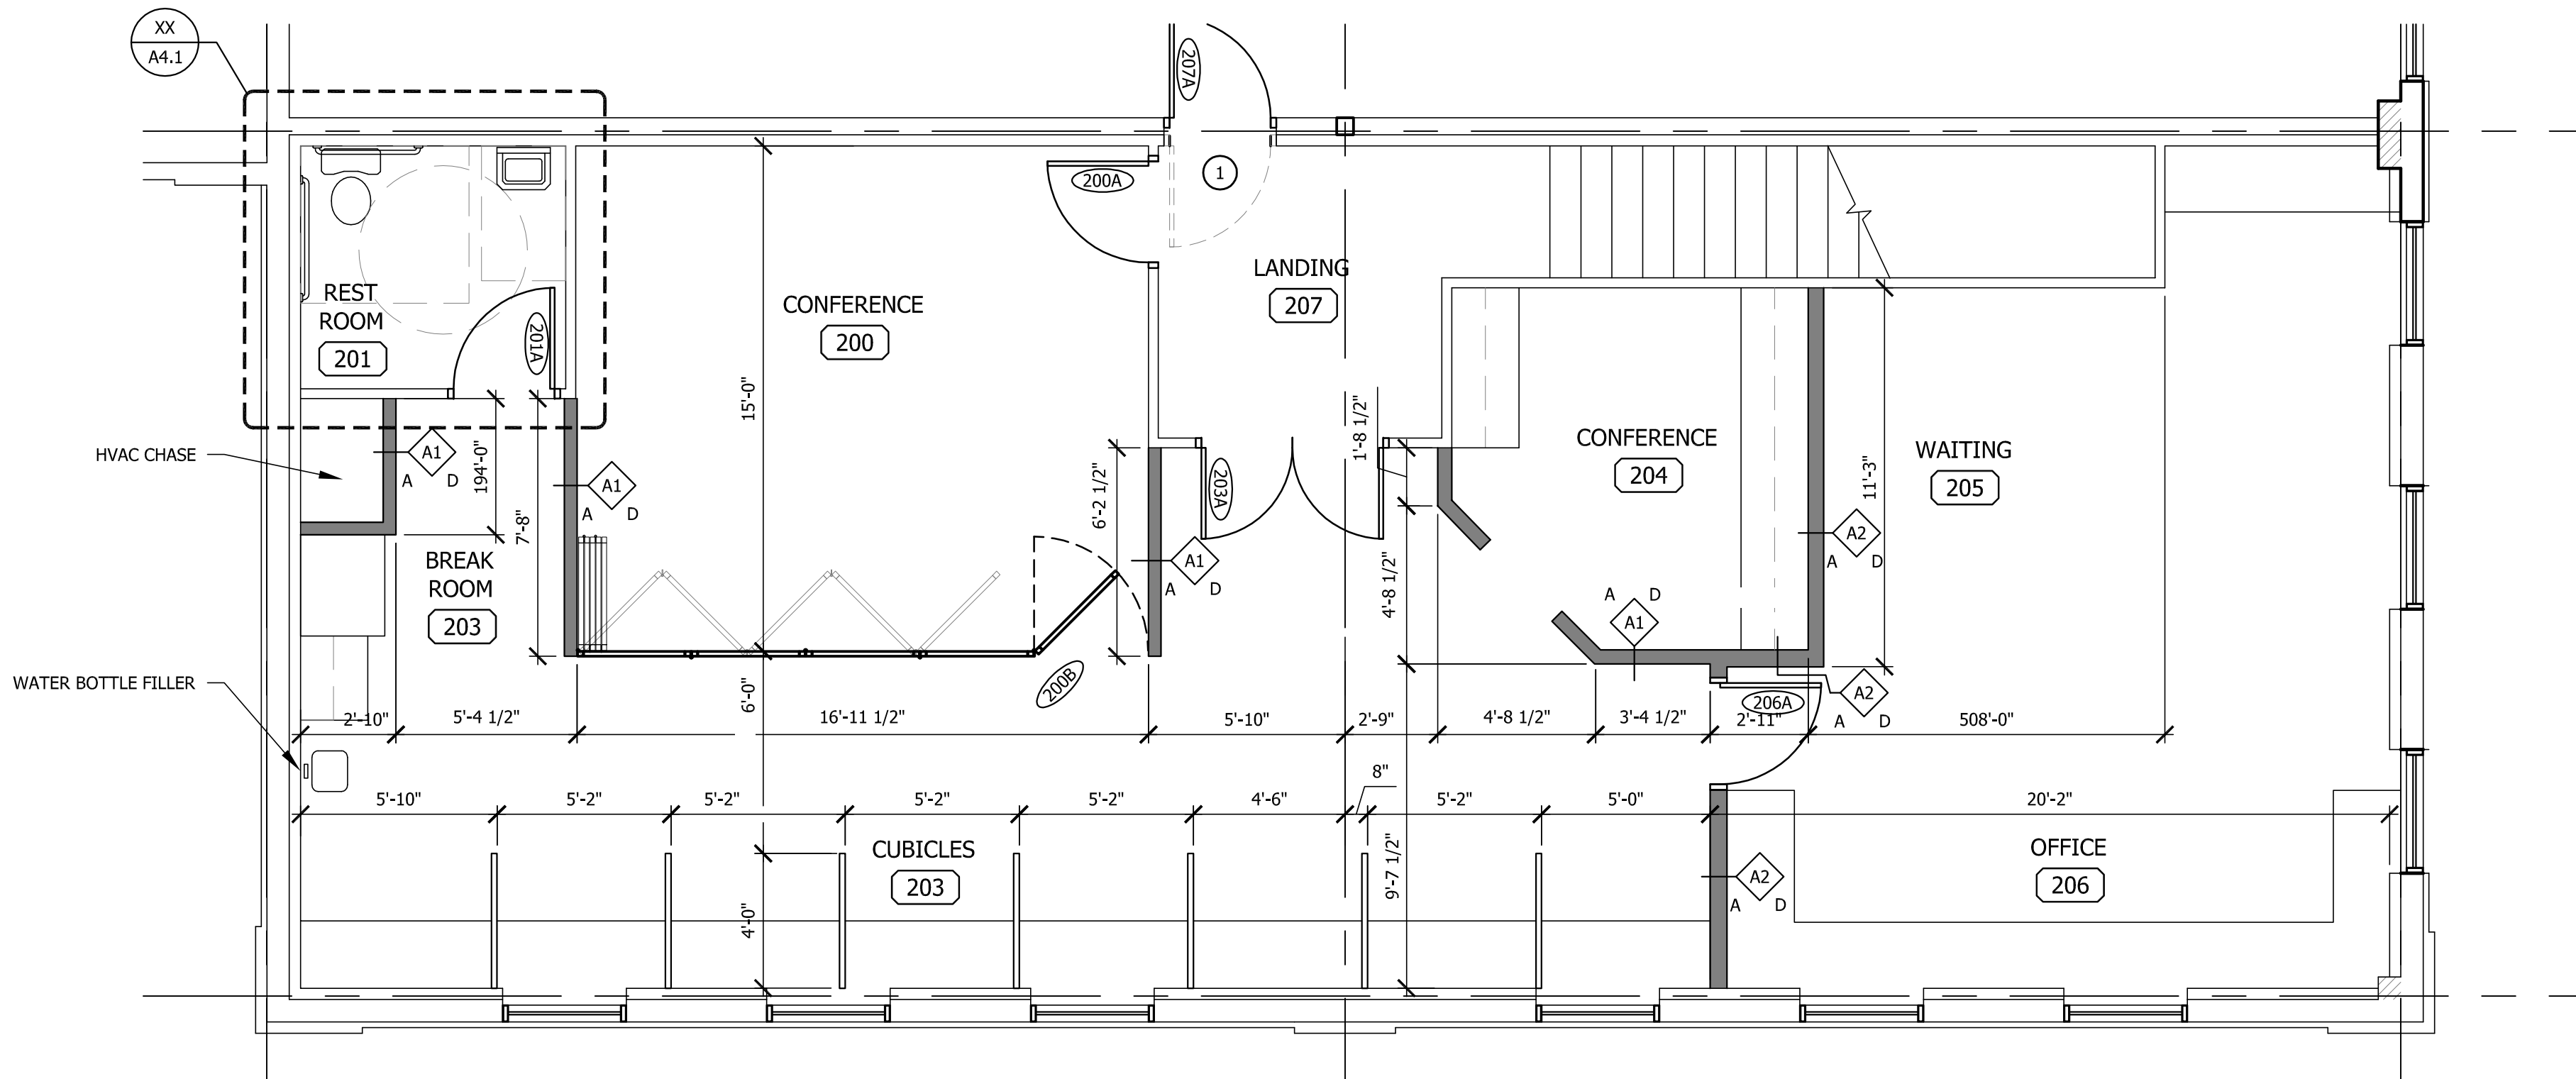

**2 SECOND FLOOR PLAN**  
SCALE: 1/4" = 1'-0"


**GENERAL NOTES**

- A. ALL GYPSUM BOARD PARTITIONS SHALL BE FINISHED TO LEVEL 4, TAPED, SANDED SMOOTH, & PAINTED COLOR AS SPECIFIED BY TENANT. THE CONTRACTOR SHALL PATCH AND REPAIR SURFACES TO MATCH ADJACENT OR ADJOINING SURFACES WHEREVER REQUIRED.
- B. ALL INTERIOR PARTITIONS ARE DIMENSIONED FACE OF STUD TO FACE OF STUD (U.O.N.).
- C. DEMISING WALLS ARE FROM FINISH FLOOR SLAB TO UNDERSIDE OF ROOF DECK ABOVE
- D. ALL DIMENSIONS TO EXTERIOR WINDOW WALL ARE TO INSIDE EDGE OF WINDOW FLOOR PLAN (U.O.N.)
- E. ALL WORK SHALL BE INSTALLED PLUMB, LEVEL, SQUARE AND TRUE. THE CONTRACTOR SHALL CORRECT LEVEL FLOORING VARIATIONS.
- F. DIMENSIONS NOTED 'CLR' ARE MINIMUM REQUIRED DIMENSIONS AND CLEARANCE MUST BE ACCURATELY MAINTAINED.
- G. THERE SHALL BE A MINIMUM OF 18" CLEAR TO THE NEAREST RETURNING PARTITION, PERMANENT FIXTURE OR MULLION AT THE LATCH SIDE, PULL SIDE OF ALL DOORS.
- H. ALL LATCH SETS AND LOCKSETS ON ALL DOORS SHALL COMPLY WITH ALL ACCESSIBLY CODES.
- I. BRACING FOR DOOR FRAME IS NOT REQUIRED AT DOOR JAMS LOCATED 6" OR LESS FROM 90 DEGREE PARTITION INTERSECTION.

**KEY NOTES**

- ① REVERSE DOOR SWING

**LEGEND**

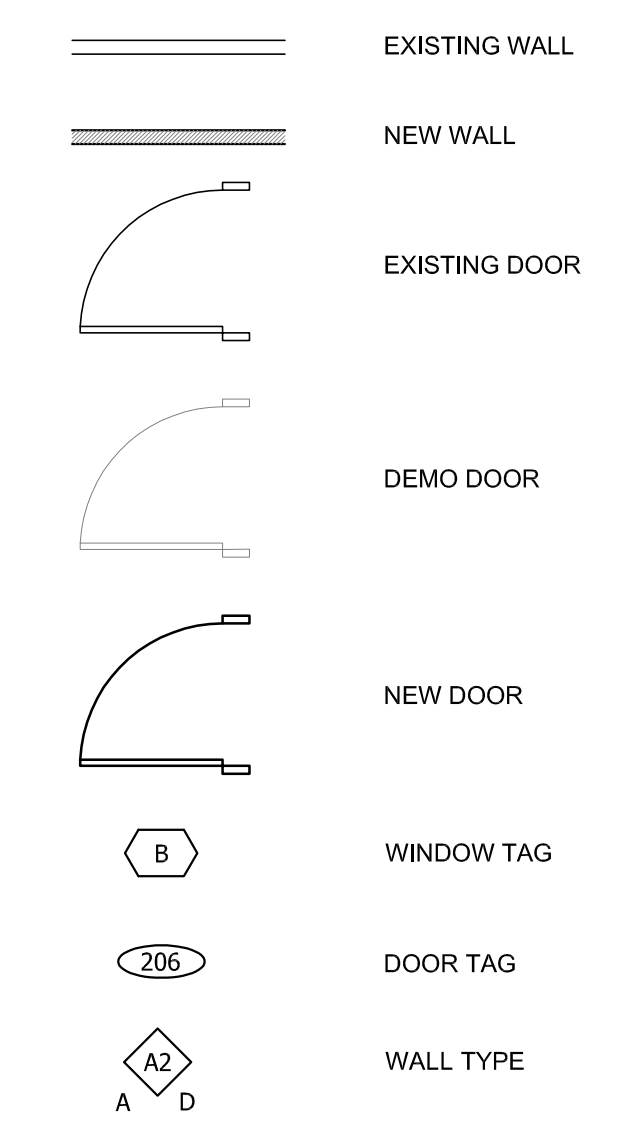

**WALL TYPES**

- A1** NEW WALL, 2X4 WOOD STUD WITH 5/8" GYPSUM BOARD ON BOTH SIDES
- A2** NEW WALL, 2X6 WOOD STUD WITH 5/8" GYPSUM BOARD ON BOTH SIDES.
- WALL HEIGHT : U.O.N. ALL WALLS ARE TO BE CONSTRUCTED FROM FIN FLOOR TO CEILING STRUCTURE/ DECK ABOVE
- D = WALL TO DECK, ABOVE
- INSULATION TYPE : A = ACOUSTICAL BATT INSULATION

LICENSED ARCHITECT  
AR-884724  
*Jeffrey R. Likes*  
3.5.2020  
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STATE OF IDAHO

NO.	REVISIONS	DATE

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DRAWN BY: JM  
CHECKED BY: RF, JL  
JOB #: 20015  
DATE: 02/07/20

FLOOR PLAN

**A1.1**

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